



INTERSECTION OF BEECHWOOD PARADE & PURCHASE ROAD, CHERRYBROOK PROPOSED PEDESTRIAN SAFETY IMPROVEMENTS

LEGEND

	EXISTING KERB & GUTTER.
	EXISTING EDGE OF BITUMEN.
	EXISTING FENCE.
	EXISTING CONCRETE PATH EDGE.
	EXISTING POWER POLE.
	EXISTING / PROPOSED SIGN.
	SURVEY TRAVERSE STATION.
	STATE SURVEY MARK.
	SURVEY REFERENCE MARKS - DRILL HOLE & WING/GALVANISED IRON PIPE.
	EXISTING WATER STOP VALVE / FIRE HYDRANT.
	EXISTING GAS VALVE / MARKER.
	EXISTING TELSTRA PIT.
	EXISTING U/G TELSTRA CABLES.
	EXISTING U/G GAS MAIN.
	EXISTING U/G ELECTRICAL CABLES.
	EXISTING OVERHEAD ELECTRICAL CABLES.
	EXISTING WATER MAIN.
	EXISTING LINE MARKING.
	PROPOSED LINE MARKING.
	PROPOSED 150mm HIGH BARRIER KERB.
	DESIGN SETOUT POINT & NUMBER.
	EXTENT OF NEW CONCRETE PAVING N20 (COLOUR: PLAIN CONCRETE).
	EXTENT OF NEW CONCRETE PAVING N20 (COLOUR: TERRACOTTA COLOURED CONCRETE).

DRAWING SCHEDULE		
SHEET No.	TITLE	ISSUE
1	DRAWING SCHEDULE, LEGEND & LOCALITY PLAN.	1
2	PROJECT NOTES.	1
3	GENERAL WORKS & SERVICES PLAN.	1
4	SETOUT PLAN & DETAILS.	1
5	SIGNS & LINE MARKING PLAN.	1

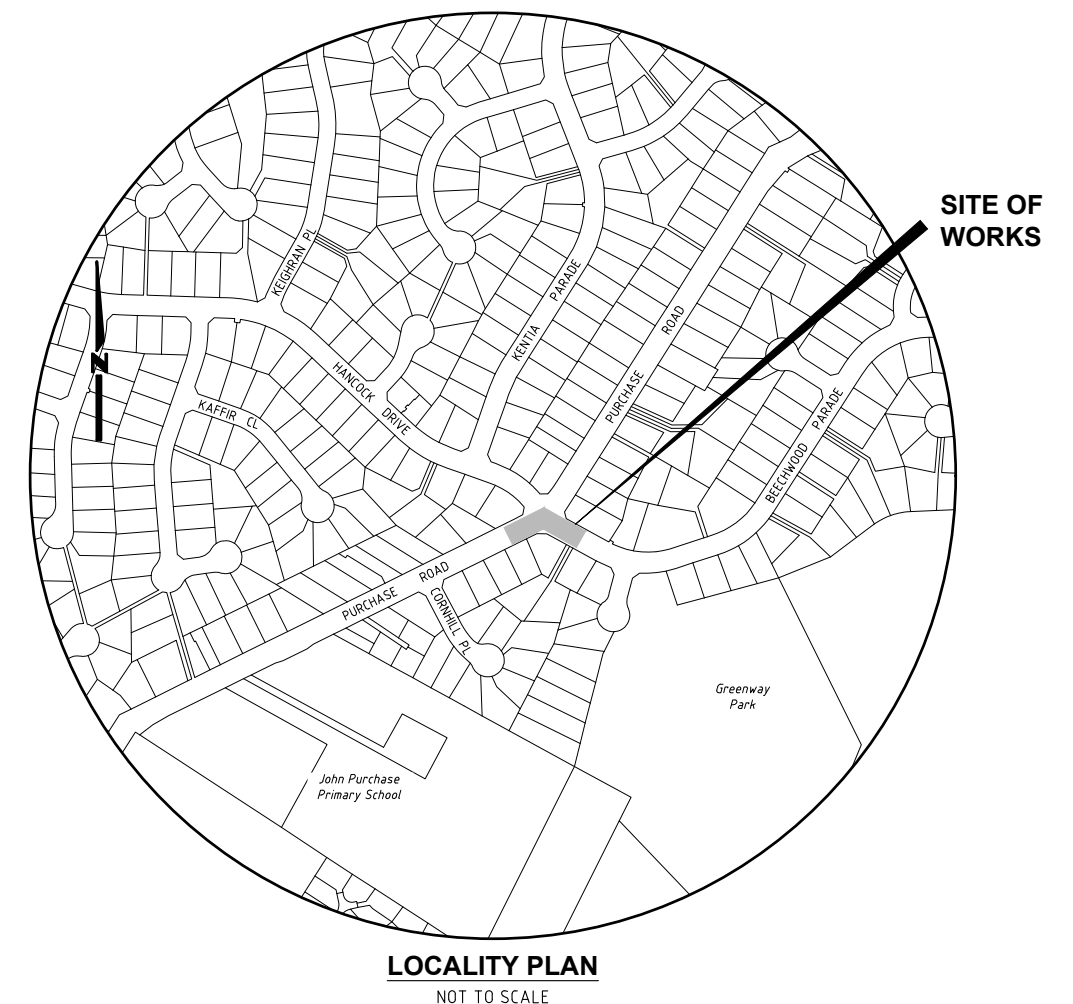

<div><h1>Hornsby Shire Council Design & Construction Branch</h1><p>TELEPHONE: (02) 9847 6666 EMAIL: hsc@hornsby.nsw.gov.au</p><p>Authorised for release - Manager Design & Construction</p></div>	Designer S. COMISH		Design Checked-Design Team Leader								<div><div>Bar Scales</div><div>NOT TO SCALE</div></div>	<div><p>HORNSBY SHIRE COUNCIL PO BOX 37, HORNSBY NSW 1630</p></div>	INTERSECTION OF BEECHWOOD PARADE & PURCHASE RD, CHERRYBROOK PROPOSED PEDESTRIAN SAFETY IMPROVEMENTS		Signed: _____ Date: _____				
	Drawn S. COMISH		Signed:										Project Number 101086		Project Number 101086				
	Surveyor J. HART		Signed:											Sheet of 1 5		Issue 1			
	Project Identifier\\-ACAD File Name H:\\\\Beechwood Pde\\TR_101086\\Design\\ACAD\\Beechwood Pde.dwg		NA Field Book		NA Level Book		AHD Datum							HSC Drawing Number 797.3		HSC Drawing Number 797.3			
	TRIM Document Number D08971529		1		ISSUED FOR CONSTRUCTION		M. DRAKE		Initial				Date		DO NOT SCALE, USE FIGURED DIMENSIONS ONLY		DO NOT SCALE, USE FIGURED DIMENSIONS ONLY		
Design not to be amended without authorisation by Manager Design & Construction														Design not to be amended without authorisation by Manager Design & Construction		Design not to be amended without authorisation by Manager Design & Construction		Design not to be amended without authorisation by Manager Design & Construction	

1. ALL WORKS TO BE CARRIED OUT IN ACCORDANCE WITH THE REQUIREMENTS & SPECIFICATIONS OF HORNSBY SHIRE COUNCIL & TRANSPORT FOR NSW.
2. LEVELS SHALL BE OBTAINED FROM ESTABLISHED BENCH MARKS & NOT FROM SURVEY PEGS.
3. PROVIDE TRAFFIC MANAGEMENT, LINE MARKING & SIGNAGE IN ACCORDANCE WITH THE TfNSW "TRAFFIC CONTROL AT WORK SITES" TECHNICAL MANUAL & AS1742.3 REQUIREMENTS.
4. SERVICES SHOWN ON THESE PLANS HAVE BEEN LOCATED FROM INFORMATION SUPPLIED FROM THE RELEVANT AUTHORITIES VIA A "DIAL BEFORE YOU DIG" ENQUIRY. THE LOCATION OF SERVICES SHOWN ON THESE DRAWINGS HAVE BEEN PLOTTED AS ACCURATELY AS POSSIBLE FROM DIAGRAMS PROVIDED BY SERVICE AUTHORITIES & FIELD INVESTIGATIONS & ARE TO BE VERIFIED PRIOR TO CONSTRUCTION.
5. EROSION & SEDIMENT CONTROL MEASURES ARE TO BE INSTALLED IN ACCORDANCE WITH THE LANDCOM PUBLICATION- "MANAGING URBAN STORMWATER, SOILS & CONSTRUCTION" Vol. 1, 4th EDITION.
6. ALL DISTURBED AREAS OF THE SITE ARE TO BE REINSTATED WITH EXISTING OR MATCHING MATERIALS UNLESS NOTED OTHERWISE AT THE COMPLETION OF THE WORKS.
7. WHERE WORKS ARE ADJACENT TO EXISTING STRUCTURES UNDERTAKE A DILAPIDATION SURVEY OF EXISTING ADJACENT STRUCTURES BEFORE COMMENCEMENT OF ANY WORKS.
8. IF SET-OUT IS REQUIRED BY HORNSBY SHIRE COUNCIL DESIGN & CONSTRUCTION BRANCH SURVEYOR. NOTIFY ENGINEERING SURVEYOR A MINIMUM OF 24 HOURS IN ADVANCE.

1. THE CONSTRUCTOR SHALL COMPLY WITH ALL STATUTORY & INDUSTRIAL REQUIREMENTS FOR PROVISION OF A SAFE WORKING ENVIRONMENT INCLUDING TRAFFIC CONTROL.
2. THE CONSTRUCTOR SHALL PROVIDE TRAFFIC MANAGEMENT PLANS FOR THE PROPOSED WORKS COMPLETED BY A SUITABLY QUALIFIED PERSON & APPROVED BY COUNCIL/REGULATORY AUTHORITY. WORK IS NOT TO COMMENCE ON SITE PRIOR TO APPROVAL OF TRAFFIC MANAGEMENT SCHEME.
3. THE CONSTRUCTOR SHALL ENSURE THAT AT ALL TIMES ACCESS TO BUILDINGS/RESIDENCES ADJACENT TO THE WORKS IS NOT DISRUPTED.
4. WHERE NECESSARY THE CONSTRUCTOR SHALL PROVIDE SAFE PASSAGE OF VEHICLES AND/OR PEDESTRIANS THROUGH OR BY THE SITE.
5. THE CONSTRUCTOR SHALL ENSURE PUBLIC ACCESS EXTERNAL TO THE SITE IS IN ACCORDANCE WITH COUNCIL REQUIREMENTS.

1. ALL WORKS WITHIN THE TREE ROOT ZONE OF ANY TREE/S TO BE RETAINED SHOULD NOT REDUCE THE USEFUL LIFE EXPECTANCY OF THE TREE/S & BE CARRIED OUT UNDER THE SUPERVISION OF AN 'AQF LEVEL 5 ARBORIST'.

TREE ROOT ZONES (TPZ)

TREE SIZE	TRZ
TREES WITH A DIAMETER AT BREAST HEIGHT GREATER THAN 800mm	9m
TREES WITH A DIAMETER AT BREAST HEIGHT BETWEEN 400mm & 800mm	7m
TREES WITH A DIAMETER AT BREAST HEIGHT LESS THAN 400mm	4m

SOIL LEVELS WITHIN THE TREE ROOT ZONE OF TREES TO BE RETAINED SHOULD REMAIN AT EXISTING GRADE & UNDISTURBED.

EXCAVATION WITHIN THE TREE PROTECTION ZONE OF TREES TO BE RETAINED SHOULD BE CARRIED OUT BY HAND EXCAVATION ONLY. HAND EXCAVATION SHOULD BE CARRIED OUT UNDER THE SUPERVISION OF A QUALIFIED ARBORIST IN SUCH A MANNER THAT IS NON-INJURIOUS TO ANY ROOTS REVEALED.

NO TREE ROOT GREATER THAN 30mm DIAMETER LOCATED WITHIN THE TPZ OF ANY TREE TO BE RETAINED SHOULD BE SEVERED OR INJURED IN THE PROCESS OF ANY WORKS.

TREE ROOTS LESS THAN 30mm IN DIAMETER REQUIRED TO BE SEVERED SHALL BE CUT CLEANLY BY HAND BY A QUALIFIED & EXPERIENCED ARBORIST OR HORTICULTURIST WITH MINIMUM QUALIFICATIONS OF HORTICULTURAL CERTIFICATE OR TREE SURGERY CERTIFICATE (AQF 3).
2. ALL PRUNING SHALL BE UNDERTAKEN AS SPECIFIED IN THE AUSTRALIAN STANDARD 'PRUNING OF AMENITY TREES' (AS 4373-2009).
3. THE FILLING OR STOCKPILING OF BUILDING MATERIALS, PARKING OF VEHICLES OR PLANT, THE USE OF MACHINERY OTHER THAN HAND HELD, DISPOSAL OF CEMENT SLURRY, WASTE WATER OR OTHER CONTAINMENTS MUST REMAIN OUTSIDE THE TREE ROOT ZONE OF ANY TREE TO BE RETAINED.
4. ANY MECHANICAL DAMAGE TO TREES OR CHEMICAL SPILLS WITHIN THE TPZ MUST BE REPORTED TO THE PROJECT SUPERVISOR/MANAGER.
5. BARRIER MESH FENCING SHALL BE ERECTED AROUND RETAINED TREES TO ENSURE THEY ARE PROTECTED FROM MACHINERY MISTAKENLY TRAVERSING BETWEEN TREES, THIS CAN BE IDENTIFIED/ DIRECTED BY PROJECT ARBORIST.

1. NO WORK SHALL BE UNDERTAKEN UNTIL ALL SEDIMENT & EROSION CONTROL MEASURES ARE IN PLACE & HAVE BEEN APPROVED BY THE CONSTRUCTION ENGINEER.
2. ALL SEDIMENT CONTROL STRUCTURES TO BE INSPECTED BY THE SITE SUPERVISOR ON A DAILY BASIS & SIGNED OFF ON THE BACK OF THE DAY SHEET. A CHECKLIST SHALL BE HANDED OVER TO THE PROJECT MANAGER AT THE END OF EACH DAY. STRUCTURES WILL ALSO BE INSPECTED AFTER EACH RAINFALL EVENT FOR STRUCTURAL DAMAGE & ALL TRAPPED SEDIMENT TO BE REMOVED TO A NOMINATED SOIL STOCKPILE SITE. THE CONSTRUCTION ENGINEER MUST INFORM ALL CONTRACTORS & SUB-CONTRACTORS OF THEIR OBLIGATIONS UNDER THE EROSION CONTROL PLAN.
3. SELECTIVE CLEARING OF VEGETATION TO BE RESTRICTED TO NOMINATED AREAS WITH CLEARED VEGETATION WINDROWED ON THE CONTOUR.
4. TREES NEAR THE CONSTRUCTION ZONE NOT OTHERWISE PROTECTED BY FENCING SHALL BE PROTECTED IN ACCORDANCE WITH AS4970 SECTION 4.5. ALTERNATIVE PROTECTION MEASURES SATISFYING THE PROJECTS ABORIST'S REQUIREMENTS IS ACCEPTABLE. TRUNK PROTECTION SHOULD BE MAINTAINED INTACT UNTIL THE COMPLETION OF ALL WORK ON THE SITE. ALL TREES REQUIRING REMOVAL ARE SHOWN ON THIS PLAN & SHALL BE MARKED ACCORDINGLY PRIOR TO REMOVAL.
5. TOPSOIL FROM AREAS THAT WILL BE DISTURBED TO BE STRIPPED & STOCKPILED AT THE NOMINATED SITE.
6. A MINIMUM STOCK OF THE FOLLOWING SHALL BE KEPT ON SITE AT ALL TIMES:
 - (A) 50m ROLL OF SEDIMENT FENCE & PEGS.
 - (B) 50m ROLL OF BIDIM GEOTEXTILE.
7. ANY DISTURBED AREA OF LAND SHALL BE COMPACTED AT THE END OF EACH WORKING DAY & BEFORE ANY STORM EVENT.
8. CONSTRUCTION AREA IS TO BE LIMITED AS SHOWN TO MINIMISE DISTURBANCE.
9. SEDIMENT FENCING SHALL BE PLACED AROUND ANY STOCKPILE AREA.
10. ALL EROSION & SEDIMENT CONTROL MEASURES ARE TO BE INSTALLED IN ACCORDANCE WITH THE LANDCOM PUBLICATION- "MANAGING URBAN STORMWATER, SOILS & CONSTRUCTION" Vol. 1, 4th EDITION.
11. ALL DISTURBED AREAS SHALL BE TURFED WITHIN 14 DAYS OF FINAL TRIMMING.

1. AN AHIMS WEB SEARCH HAS BEEN UNDERTAKEN FOR THIS PROJECT (REF: 859580 -31st JANUARY 2024). NO ARTIFACTS WERE IDENTIFIED. SHOULD ANY POTENTIAL ARTIFACTS BE UNCOVERED THEY ARE NOT TO BE REMOVED FROM THE SITE & SHALL BE IMMEDIATELY REPORTED TO COUNCIL'S PROJECT MANAGER.

1. SIGNS & LINE MARKING TO BE INSTALLED IN ACCORDANCE WITH AS1742.9 -MANUAL OF UNIFORM TRAFFIC CONTROL DEVICES.
2. WHERE POSSIBLE EXISTING SIGNAGE IS TO BE CLEANED / RELOCATED OR REUSED TO SUIT NEW WORK.
3. ALL NEW LINE MARKING TO WHITE THERMOPLASTIC PAINT UNLESS NOTED OTHERWISE.
4. REMOVE REDUNDANT LINE MARKING.
5. LINE MARKING SHALL BE SPOTTED OUT & APPROVED PRIOR TO APPLICATION.

1. MATERIALS AND CONSTRUCTION: TO AS 3600, AS 3610.
STEEL REINFORCEMENT MATERIALS: TO AS 4671.

2. CONCRETE QUALITY: TO AS 1379
READY MIX CONCRETE: TO AS 1379

a) DO NOT USE ADMIXTURES WITHOUT WRITTEN APPROVAL FROM SUPERVISING ENGINEER.

b) CEMENT: TYPE 'GP' OR 'GB' TO AS 3972.

c) MAXIMUM SIZE OF COARSE AGGREGATE: 20mm.

d) CONCRETE SLUMP: 80mm U.N.O.

ELEMENT	CHARACTERISTIC CONCRETE STRENGTH(f'c) AT 28 DAYS	COVER	SPECIAL REQUIREMENTS
KERB RAMPS	N 25 (U.N.O.)	AS DETAILED	BROOM FINISH & PLAIN CONCRETE COLOURED.

3. VERIFY STRENGTH BY PRODUCTION CONTROL TESTING TO AS 1379.

4. NO UNSPECIFIED HOLES, DUCTING OR CHASES ARE PERMITTED WITHOUT WRITTEN APPROVAL FROM SUPERINTENDING (SUPERVISING OFFICER). NO PIPES OR CONDUITS ARE PERMITTED WITHIN CONCRETE COVER.

5. STRUCTURAL DIMENSIONS DO NOT INCLUDE TOPPINGS OR FINISHES.

6. FORM CONSTRUCTION JOINTS ONLY AT LOCATIONS SHOWN ON DRAWINGS. DO NOT VARY WITHOUT WRITTEN APPROVAL FROM SUPERVISING ENGINEER.

7. PREPARE COLD JOINTS BY LIGHT SCABBLING, REMOVAL OF DEBRIS & WASHING WITH CLEAN WATER.

8. FOUNDATION MATERIALS MUST BE CAPABLE OF WITHSTANDING A SAFE BEARING PRESSURE OF 100kPa. VERIFY & RECORD THE BEARING CAPACITY BEFORE ANY CONCRETE IS PLACED.

9. DO NOT PLACE CONCRETE UNTIL REINFORCEMENT (IF USED) & FORMWORK ARE INSPECTED BY SUPERVISING ENGINEER.

10. THOROUGHLY CLEAN OUT ALL FORMWORK PRIOR TO POURING.

11. DO NOT PLACE CONCRETE UNDER THE FOLLOWING CONDITIONS:

a) WHEN THE SURROUNDING OUTDOOR TEMPERATURE EXCEEDS 30°C.

b) WHEN THE SURROUNDING WIND SPEED EXCEEDS 12 KNOTS.

12. IMPLEMENT THE FOLLOWING PROCEDURES TO MITIGATE PREMATURE DRYING & CRACKING OF THE CONCRETE:

a) IN HOT CONDITIONS, PROGRAM CONCRETE PLACEMENT FOR THE COOLER PART OF THE DAY (ie. EARLY MORNING).

b) SPRAY EVAPORATIVE RETARDERS WITH FUGATIVE DYES (eg. ALIPHATIC ALCOHOL) OVER THE SURFACE IMMEDIATELY AFTER SCREEDING & WHILST BLEED WATER IS STILL PRESENT. REAPPLY IF THE SURFACE IS DISTURBED.


c) COMMENCE CURING IMMEDIATELY AFTER FINISHING. CURE FOR 7 DAYS.


13. VIBRATE CONCRETE DURING PLACEMENT TO GIVE MAXIMUM COMPACTION WITHOUT SEGREGATION.

14. SURFACE FINISH – REFER TO DRAWINGS FOR DETAILS.

15. COMMENCE CURING OF ALL CONCRETE SURFACES IMMEDIATELY ON FINISHING & CONTINUE FOR 7 DAYS MIN.

16. EXPANSION JOINTS & ISOLATION JOINTS ARE TO BE SEALED TO MANUFACTURER'S SPECIFICATIONS WITH A GUN GRADE POLYURETHANE LOW MODULUS SELF PRIMING SEALANT EQUAL TO 'TREMCO DYMONIC NT' (+100%, -50% MOVEMENT CAPACITY). SEALANT COLOUR GREY OR EQUIVALENT.

<div>Hornsby Shire Council Design & Construction Branch</div> <div>TELEPHONE: (02) 9847 6666 EMAIL: hsc@hornsby.nsw.gov.au</div>	Designer S. COMISH	Design Checked-Design Team Leader									<div>Bar Scales</div> <div>NOT TO SCALE</div>	 <div>HORNSBY SHIRE COUNCIL PO BOX 37, HORNSBY NSW 1630</div>	INTERSECTION OF BEECHWOOD PARADE & PURCHASE RD, CHERRYBROOK PROPOSED PEDESTRIAN SAFETY IMPROVEMENTS			Project Number 101086	
	Drawn S. COMISH	Signed:											Sheet of	Issue			
	Surveyor J. HART	Drawing Checked											2	5	1		
		Signed:															
	Field Book	Level Book	AHD Datum														
	Project Identifier\VCAD File Name H:\\\\Beechwood Pde_TR_101086\\Design\\ACAD\\Beechwood Pde.dwg			1	ISSUED FOR CONSTRUCTION			M. DRAKE									
	TRM Document Number D08971529			Issue	Description			Name	Initial	Date			DO NOT SCALE, USE FIGURED DIMENSIONS ONLY				
Name: R. RAJCA Signed: Date:			Design not to be amended without authorisation by Manager Design & Construction														

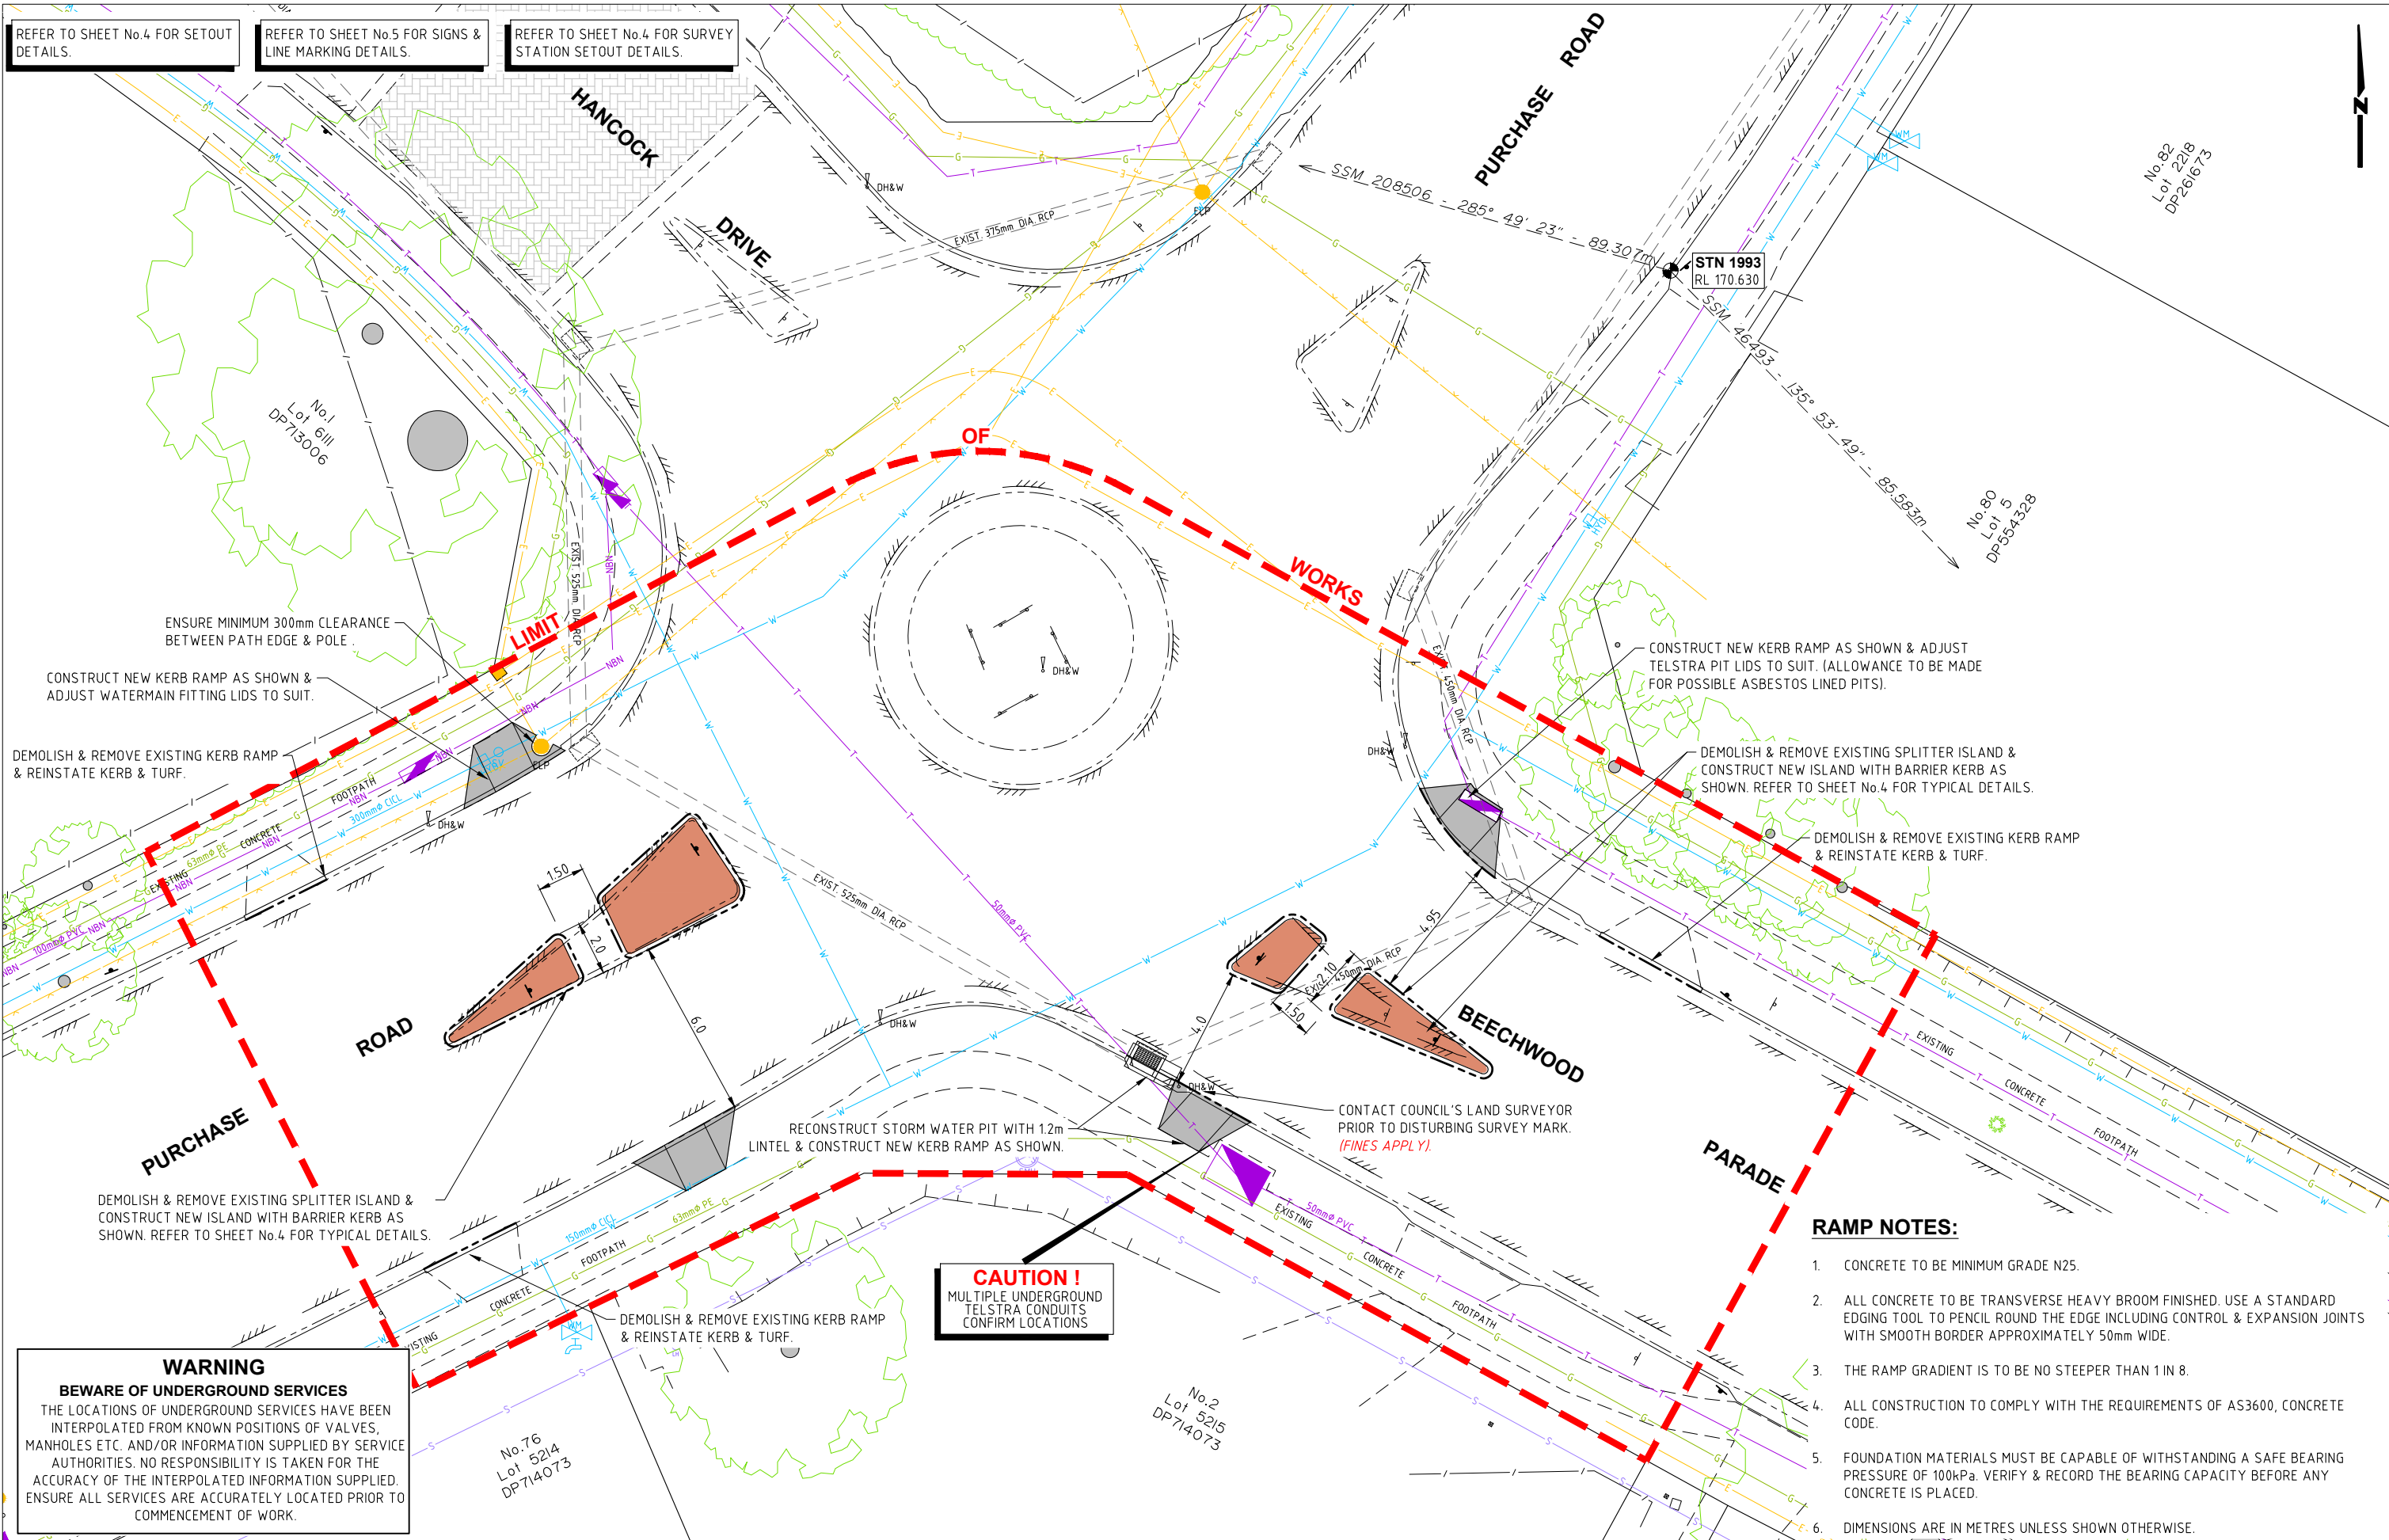

Hornsby Shire Council

Design & Construction

Branch

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Authorised for release - Manager Design & Construction
Name: R. RAJCA Signed: Date:

Designer
S. COMISH

Drawn
S. COMISH

Surveyor
J. HART

Project Identifier\VCAD File Name
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TRIM Document Number
D08971529

Design Checked-Design Team Leader

Signed: _____

Drawing Checked

Signed: _____

NA	NA	AHD
Field Book	Level Book	Datum

1 ISSUED FOR CONSTRUCTION M. DRAKE

Issue	Description	Name	Initial	Date

Design not to be amended without authorisation by Manager Design & Construction

Bar Scales

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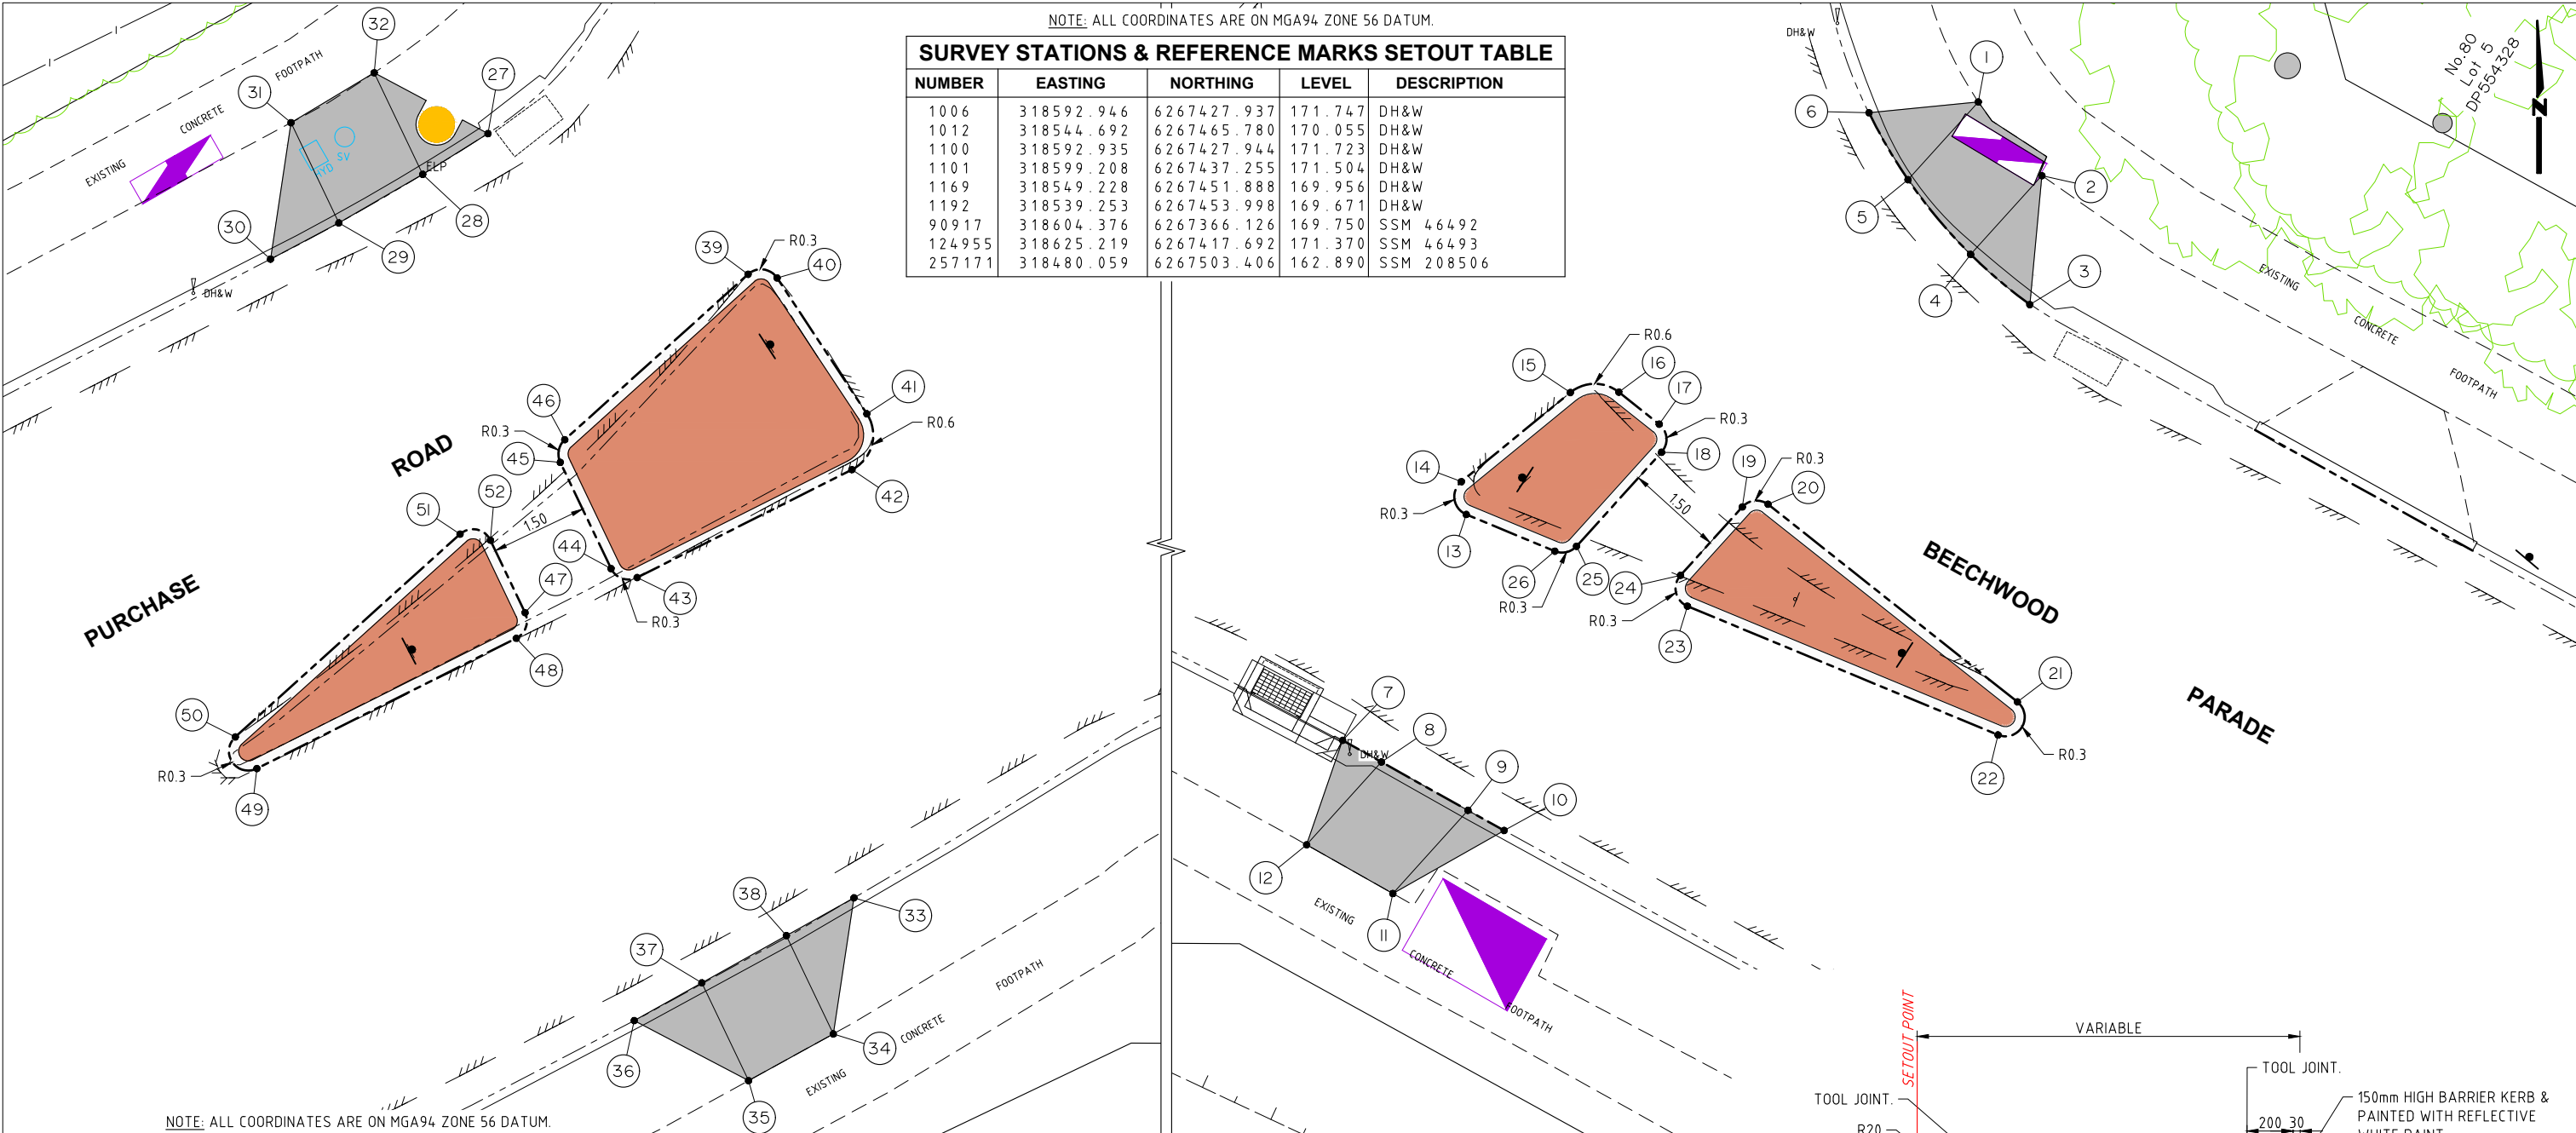
DO NOT SCALE, USE FIGURED DIMENSIONS ONLY

HORNSBY
SHIRE COUNCIL
PO BOX 37, HORNSBY NSW 1630

INTERSECTION OF BEECHWOOD PARADE & PURCHASE RD, CHERRYBROOK PROPOSED PEDESTRIAN SAFETY IMPROVEMENTS

GENERAL WORKS & SERVICES PLAN

Project Number 101086		
Sheet 3	of 5	Issue 1
HSC Drawing Number 797.3		



KERB RAMP SETOUT DETAILS			
POINT No.	EASTING	NORTHING	REMARKS
1	318558.990	6267462.016	TOP OF RAMP/EDGE OF PATH
2	318559.977	6267460.871	TOP OF RAMP/EDGE OF PATH
3	318559.790	6267458.863	WING OF RAMP
4	318558.871	6267459.648	BOT OF RAMP/INVERT OF KERB
5	318557.898	6267460.809	BOT OF RAMP/INVERT OF KERB
6	318557.293	6267461.847	WING OF RAMP
7	318549.118	6267452.105	WING OF RAMP
8	318549.721	6267451.768	BOT OF RAMP/INVERT OF KERB
9	318551.064	6267451.016	BOT OF RAMP/INVERT OF KERB
10	318551.628	6267450.705	WING OF RAMP
11	318549.898	6267449.726	TOP OF RAMP/EDGE OF PATH
12	318548.559	6267450.483	TOP OF RAMP/EDGE OF PATH
27	318528.725	6267463.118	WING OF RAMP
28	318527.712	6267462.485	BOT OF RAMP/INVERT OF KERB
29	318526.409	6267461.731	BOT OF RAMP/INVERT OF KERB
30	318525.348	6267461.169	WING OF RAMP
31	318525.666	6267463.287	TOP OF RAMP/EDGE OF PATH
32	318526.958	6267464.062	TOP OF RAMP/EDGE OF PATH
33	318534.408	6267451.252	WING OF RAMP
34	318534.087	6267449.140	TOP OF RAMP/EDGE OF PATH
35	318532.772	6267448.415	TOP OF RAMP/EDGE OF PATH
36	318530.996	6267449.347	WING OF RAMP
37	318532.052	6267449.921	BOT OF RAMP/INVERT OF KERB
38	318533.358	6267450.666	BOT OF RAMP/INVERT OF KERB

ISLAND SETOUT DETAILS			
POINT No.	EASTING	NORTHING	REMARKS
13	318551.038	6267455.611	TP R 0.3m
14	318550.962	6267456.121	TP R 0.3m
15	318552.655	6267457.504	TP R 0.6m
16	318553.407	6267457.510	TP R 0.6m
17	318554.035	6267457.013	TP R 0.3m
18	318554.071	6267456.577	TP R 0.3m
19	318555.326	6267455.728	TP R 0.3m
20	318555.724	6267455.770	TP R 0.3m
21	318559.598	6267452.701	TP R 0.3m
22	318559.297	6267452.189	TP R 0.3m
23	318554.473	6267454.187	TP R 0.3m
24	318554.365	6267454.666	TP R 0.3m
25	318552.751	6267455.117	TP R 0.3m
26	318552.413	6267455.041	TP R 0.3m
39	318532.764	6267460.933	TP R 0.3m
40	318533.215	6267460.876	TP R 0.3m
41	318534.608	6267458.767	TP R 0.6m
42	318534.377	6267457.900	TP R 0.6m
43	318531.041	6267456.225	TP R 0.3m
44	318530.636	6267456.364	TP R 0.3m

ISLAND SETOUT DETAILS (CONT)			
POINT No.	EASTING	NORTHING	REMARKS
45	318529.848	6267458.014	TP R 0.3m
46	318529.917	6267458.366	TP R 0.3m
47	318529.300	6267455.680	TP R 0.3m
48	318529.164	6267455.283	TP R 0.3m
49	318525.136	6267453.260	TP R 0.3m
50	318524.801	6267453.751	TP R 0.3m
51	318528.291	6267456.899	TP R 0.3m
52	318528.763	6267456.805	TP R 0.3m

SURVEY MARKS:
NOTE: SURVEY MARKS MUST NOT BE DISTURBED. IF MARKS HAVE TO BE REMOVED APPLICATION MUST BE MADE THROUGH A REGISTERED SURVEYOR TO SUBMIT A "PRESERVATION OF SURVEY INFRASTRUCTURE" FORM TO SPATIAL SERVICES NSW.

Hornsby Shire Council

Design & Construction

Branch

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Authorised for release - Manager Design & Construction

Name: R. RAJCA

Designer

S. COMISH

Design Checked-Design Team Leader

Signed:

Drawn

S. COMISH

Surveyor

J. HART

Project Identifier\VCAD File Name

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TRIM Document Number

D08971529

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ISSUED FOR CONSTRUCTION

M. DRAKE

Issue

Description

Name

Initial

Date

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Bar Scales

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SCALE 1:50

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HORNSBY

SHIRE COUNCIL

PO BOX 37, HORNSBY NSW 1630

INTERSECTION OF BEECHWOOD PARADE & PURCHASE RD, CHERRYBROOK PROPOSED PEDESTRIAN SAFETY IMPROVEMENTS

SETOUT PLAN & DETAILS

Project Number

101086

Sheet

of


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HSC Drawing Number

797.3



THIS DRAWING
SHALL ONLY BE
REPRODUCED AND
READ IN COLOUR

REFER TO SHEET No.4 FOR SURVEY
STATION SETOUT DETAILS.

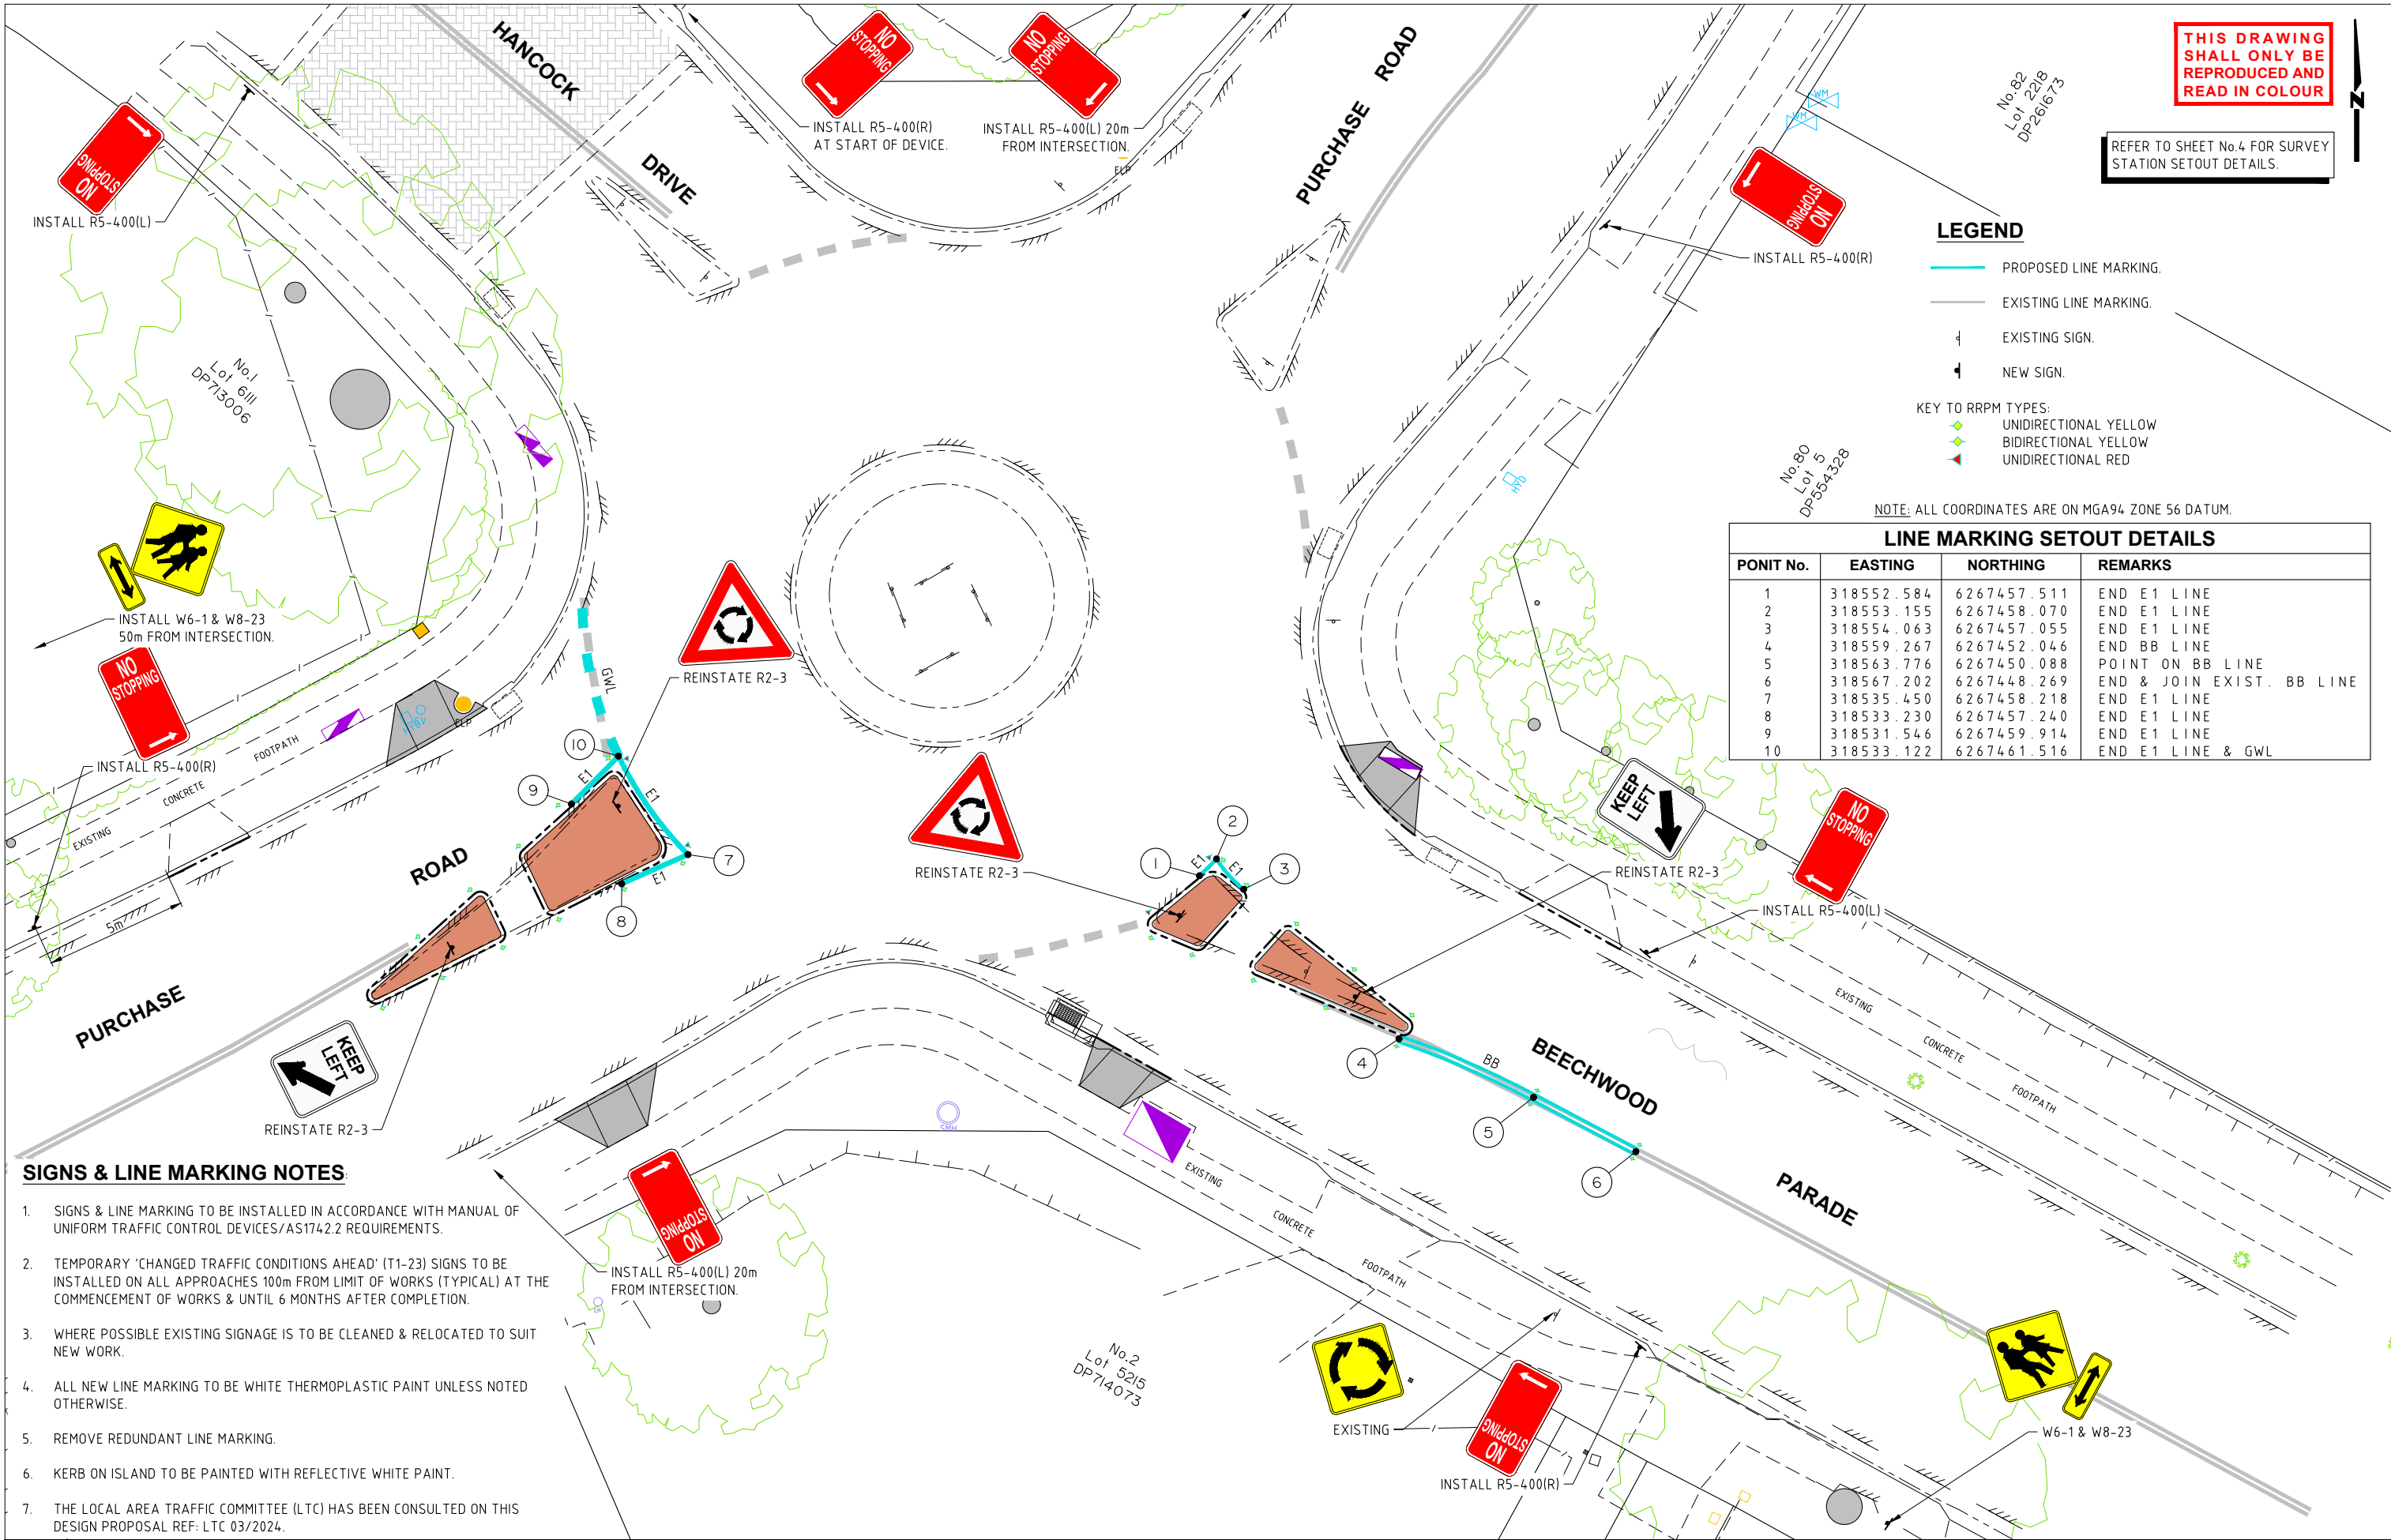LEGEND

- PROPOSED LINE MARKING.
- EXISTING LINE MARKING.
- EXISTING SIGN.
- NEW SIGN.

- KEY TO RRPM TYPES:
- UNIDIRECTIONAL YELLOW
 - BIDIRECTIONAL YELLOW
 - UNIDIRECTIONAL RED

NOTE: ALL COORDINATES ARE ON MGA94 ZONE 56 DATUM.

LINE MARKING SETOUT DETAILS

PONIT No.	EASTING	NORTHING	REMARKS
1	318552.584	6267457.511	END E1 LINE
2	318553.155	6267458.070	END E1 LINE
3	318554.063	6267457.055	END E1 LINE
4	318559.267	6267452.046	END BB LINE
5	318563.776	6267450.088	POINT ON BB LINE
6	318567.202	6267448.269	END & JOIN EXIST. BB LINE
7	318535.450	6267458.218	END E1 LINE
8	318533.230	6267457.240	END E1 LINE
9	318531.546	6267459.914	END E1 LINE
10	318533.122	6267461.516	END E1 LINE & GWL

SIGNS & LINE MARKING NOTES

- SIGNS & LINE MARKING TO BE INSTALLED IN ACCORDANCE WITH MANUAL OF UNIFORM TRAFFIC CONTROL DEVICES/AS1742.2 REQUIREMENTS.
- TEMPORARY 'CHANGED TRAFFIC CONDITIONS AHEAD' (T1-23) SIGNS TO BE INSTALLED ON ALL APPROACHES 100m FROM LIMIT OF WORKS (TYPICAL) AT THE COMMENCEMENT OF WORKS & UNTIL 6 MONTHS AFTER COMPLETION.
- WHERE POSSIBLE EXISTING SIGNAGE IS TO BE CLEANED & RELOCATED TO SUIT NEW WORK.
- ALL NEW LINE MARKING TO BE WHITE THERMOPLASTIC PAINT UNLESS NOTED OTHERWISE.
- REMOVE REDUNDANT LINE MARKING.
- KERB ON ISLAND TO BE PAINTED WITH REFLECTIVE WHITE PAINT.
- THE LOCAL AREA TRAFFIC COMMITTEE (LTC) HAS BEEN CONSULTED ON THIS DESIGN PROPOSAL REF: LTC 03/2024.


Hornsby Shire Council
Design & Construction
Branch

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Authorised for release - Manager Design & Construction
Name: R. RAJCA Signed: Date:

Designer
S. COMISH
Drawn
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Surveyor
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Design Checked-Design Team Leader
Signed:
Drawing Checked
Signed:
NA Field Book NA Level Book AHD Datum

1	ISSUED FOR CONSTRUCTION	M. DRAKE		
Issue	Description	Name	Initial	Date
Design not to be amended without authorisation by Manager Design & Construction				

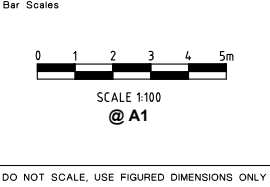

INTERSECTION OF BEECHWOOD PARADE & PURCHASE RD, CHERRYBROOK PROPOSED PEDESTRIAN SAFETY IMPROVEMENTS

SIGNS & LINE MARKING PLAN

Project Number	101086		
Sheet	5	of	5
Issue	1		
HSC Drawing Number	797.3		